

LEGEND EXISTING SURFACE WATER PROPOSED SURFACE WATER CONCRETE ENCASED SURFACE WATER-SURFACE WATER MANHOLE C.L. = 0.000I.L. = 0.000LAND DRAIN CATCH PIT POND/LAKE/SURFACE WATER RETENTION POND LINER EXISTING LEVELS + 100.000 **\$** 100.000 PROPOSED LEVELS TOW 100.00 TOP OF WATER LEVELS SILT FENCE BERM AREA WETLAND PLANTING

SEQUENCE OF DRAINAGE POND WORKS TO BE COMPLETED PRIOR TO ANY OTHER

1. EXTENTS OF 3 NO. PONDS SHALL BE EXCAVATED AS ONE DIG. THE SIDES OF THE EXCAVATION SHALL BE MAXIMUM 1:3 SLOPE. 2. 2 MM HDPE IMPERMEABLE LINER WITH WELDED JOINTS WRAPPED IN A

GEOTEXTILE FLEECE SHALL BE LAID ACROSS EXCAVATION, WITH A MINIMUM LAP LENGTH OF 300 MM. 3. 50 MM DEEP LAYER OF 20 MM SINGLE SIZED CLEAN STONE SHALL BE PLACED

ACROSS BASE OF EXCAVATION. 4. STONE CHECK DAMS SHALL BE CONSTRUCTED WITH 20 MM SINGLE SIZED CLEAN

FOLLOWING COMPLETION OF MAJOR EARTHWORKS

1. POND INLET SHALL BE TEMPORARILY BUNGED AND PONDS DRAINED TO PERMIT POND WORKS. ANY PUMPED WATER TO DISCHARGE VIA A SILT BAG - NO DISCHARGE DIRECT TO WATERCOURSE PERMITTED.

2. SEDIMENT, SILT, STONE CHECK DAMS, STONE BEDDING AND LINER SHALL BE REMOVED AND DISPOSED OF IN A LICENCED WASTE FACILITY.

3. NEW 2 MM HDPE IMPERMEABLE LINER WITH WELDED JOINTS WRAPPED IN A GEOTEXTILE FLEECE SHALL BE LAID ACROSS EXCAVATION, WITH A MINIMUM LAP

4. NEW 250 MM DEEP LAYER OF 20 MM SINGLE SIZED CLEAN STONE SHALL BE PLACED ACROSS BASE AND SIDES OF THE EXCAVATION.

5. NEW STONE CHECK DAMS SHALL BE CONSTRUCTED WITH 20 MM SINGLE SIZED CLEAN STONE.

6. WETLAND PLANTING TO BE TO BE PLANTED IN 1 M GRID ARRANGEMENT IN SECONDARY SETTLEMENT POND, CONSISTING OF: YELLOW IRIS (40%), RED CANARY

GRASS (40%), PURPLE LOOSESTRIFE (10%), MARSH THISTLE (5%) AND WATERMINT (5%), UNLESS OTHERWISE AGREED DURING CONSTRUCTION. 7. WETLAND PLANTING TO BE TO BE PLANTED IN 1 M GRID WETLAND PLANTING TO BE TO BE PLANTED IN 1 M GRID ARRANGEMENT IN FINAL SETTLEMENT POND,

CONSISTING OF: GREAT POND SEDGE (40%), BOTTLE SEDGE (30%), MARSH MARIGOLD (10%), COMMON WATER PLAINSTAIN (10%) AND WATER-ME-NOT (10%), UNLESS OTHERWISE AGREED DURING CONSTRUCTION.

7	AUG. '23	NOTES REVISED				
6	APR. '23	DRAINAGE POND SYSTEM 1 MOVED	JB	JB	RMcG	ВМ
5	FEB. '23	TEMPORARY POND DETAILS ADDED	JB	JB	RMcG	вм
4	FEB. '23	POND DRAINAGE SYSTEM 1 REVISED	JB	JB	RMcG	ВМ
3	JAN. '23	ISSUED FOR CONSTRUCTION	JB	JB	DOM	вм
2	FEB. '22	ISSUED FOR TENDER	JB	JB	DOM	ВМ
1	OCT 19	ISSUED FOR TENDER	LK	RC	DW	GH
0	JULY'17	ISSUED FOR CLIENT APPROVAL	LK	LK	DW	DS
REV	DATE	REVISION DESCRIPTION	DRN	PROD	VER	APP

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**ESB NETWORKS** 

PURPOSE OF ISSUE - PRELIMINARY UNLESS INDICATED CLIENT APPROVAL PLANNING TENDER CONSTRUCTION AS-BUILT

Coolnabacky 400 kV Station

COOLNABACKY 400 kV STATION

CIVIL DRAINAGE PONDS DETAILS


PRODUCTION UNIT Civil & Environmental Engineering




**Engineering and Major Projects,** One Dublin Airport Central, Dublin Airport, Cloghran, Co. Dublin, K67 XF72, Ireland. Tel: +353 (0)1 703 8000 Web: www.esb.ie Engineering and Major Projects is a division of ESB.

DRAWN	PRODUCED	VERIFIED	APPROVED	APPROVAL DATE	
J.Byrne	H.Griffin	R. McGowan	B.Murphy	29/08/2023	
CLIENT REF		NO. OF SHTS	SIZE	SCALE	
TC	218248	1	A1	1:25	

SHEET REV PE493-D108-054-010-007

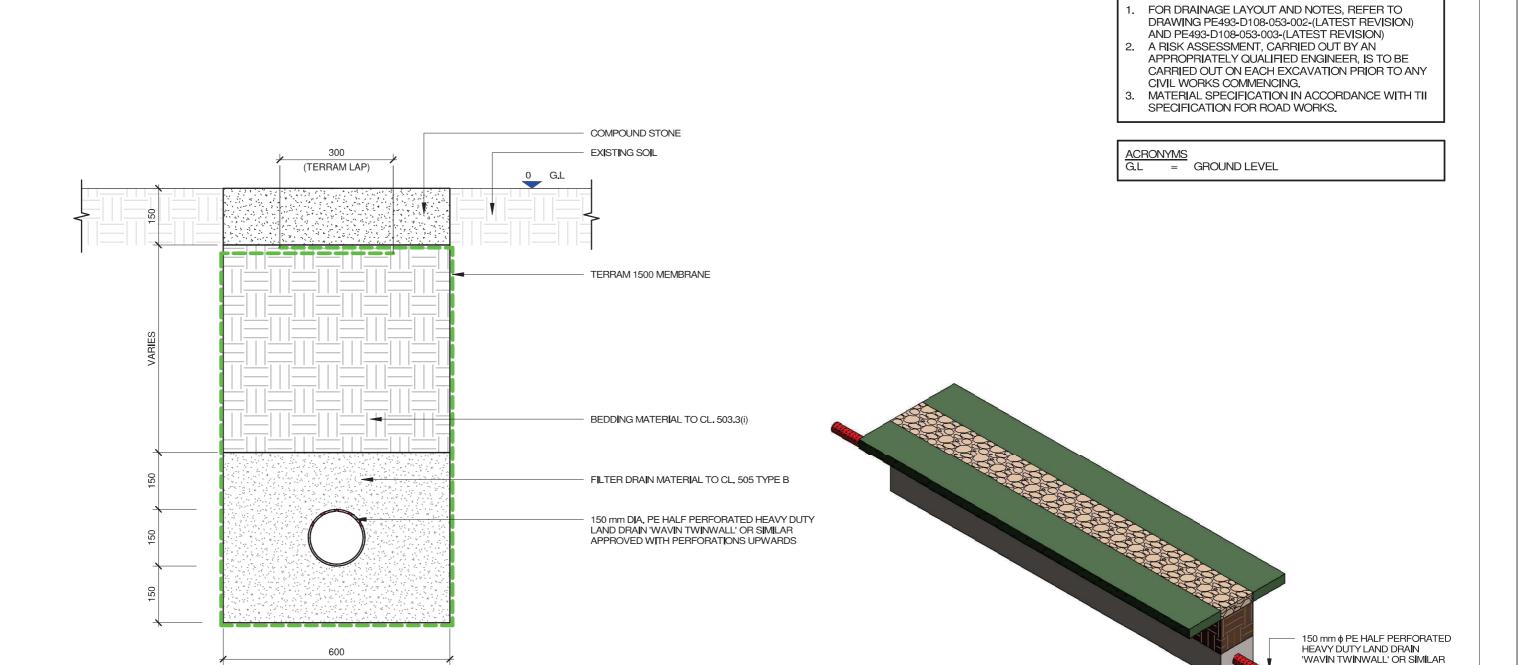

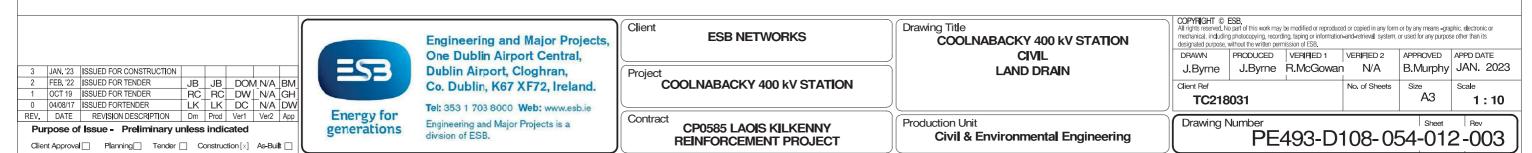



TYPICAL SECTION THROUGH LAND DRAIN SCALE: 1:10

ISOMETRIC VIEW

APPROVED WITH PERFORATIONS UPWARDS

NOTE:

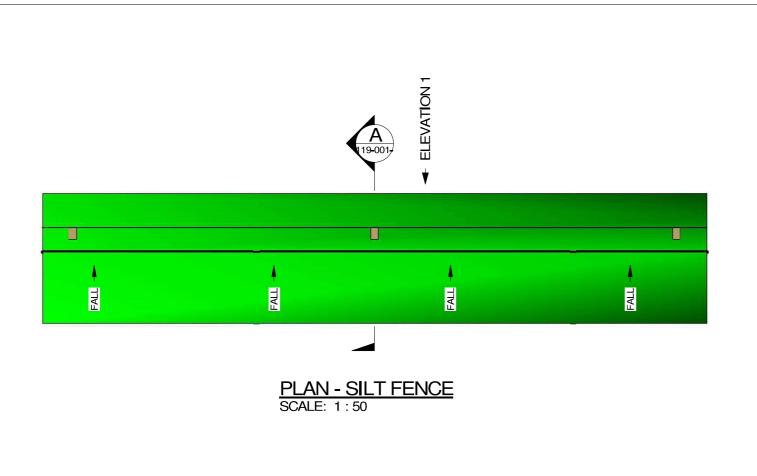

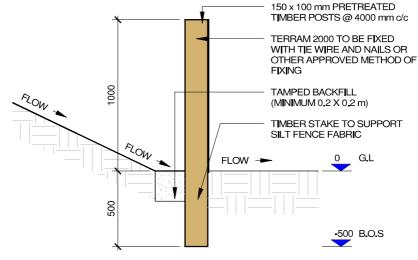

SECTION A-A SCALE: 1:25

# NOTE:

- CHECK DAMS TO BE INSTALLED USING HAND TOOLS ONLY TO AVOID GROUND DISTURBANCE BY MACHINERY.
- 2. CHECK DAMS TO BE INSPECTED AT LEAST DAILY (MORE FREQUENTLY DURING RAINFALL PERIODS) AND BUILD UP OF SILT TO BE REMOVED BY HAND AND DISPOSED OF APPROPRIATELY.
- REFER TO DRAWING PG406-D100-001-002 (LATEST REVISION) FOR GENERAL CONSTRUCTION NOTES.
- A RISK ASSESSMENT, CARRIED OUT BY AN APPROPRIATELY QUALIFIED ENGINEER, IS TO BE CARRIED OUT ON EACH EXCAVATION PRIOR TO ANY CIVIL WORKS COMMENCING.

G.L = GROUND LEVEL B.O.S = BOTTOM OF TIMBER STAKE

TERRAM 2000 TO BE FIXED WITH TIE WIRE AND NAILS OR OTHER APPROVED METHOD OF

 $150 \times 100 \text{ mm PRETREATED}$ TIMBER POSTS @ 4000 mm c/c

4000

SILT FENCE FABRIC

500 B.O.S

ELEVATION 1 SCALE: 1:50

**ESB NETWORKS** 

Project
GENERAL CIVIL DRAWINGS & NOTES

COOLNABACKY 400 kV SUBSTATION CIVIL

SILT FENCE DETAIL

Production Unit

**ISOMETRIC VIEW** 

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	indicated							
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Client Ref			No. of Sheets	Size	Scalle			
J.Byrne	J.Byrne	R.McGowan	N/A	B.Murphy	Feb. 2023			
DRAWN	PRODUCED	VERIFIED 1	VERIFIED 2	APPROVED	APPD DATE			
designated purpose, without the written permission of ESB								

PE493-D108-119-001-000

0 FEB. '23 ISSUED FOR CONSTRUCTION REV. DATE REVISION DESCRIPTION Dm Prod Ver1 Ver2 App Purpose of Issue - Preliminary unless indicated

Client Approval Planning Tender Construction X As-Built

4000

**Energy for** generations

Tel: 353 1 703 8000 Web: www.esb.ie Engineering and Major Projects is a division of ESB.

Co. Dublin, K67 XF72, Ireland.

**Engineering and Major Projects**,

One Dublin Airport Central,

Dublin Airport, Cloghran,

Contract


Transmission and Distribution Delivery

Drawing Number

# 1685 (VARIES SUBJECT TO PIPE SIZE) 300 VARIES, 300 215 mm BLOCK WALL C30/37 CONCRETE BASE WITH BOTTOM LAYER OF A393 MESH

# PLAN - TYPICAL HEADWALL DETAIL

SCALE: 1:25

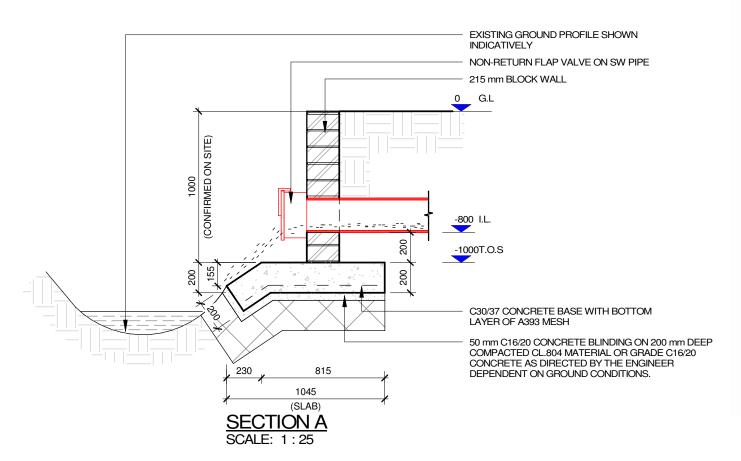

# NOTE:


- FOR DRAINAGE LAYOUT AND NOTES, REFER TO DRAWING PE493-D108-053-002-(LATEST REVISION) AND PE493-D108-053-003-(LATEST REVISION)
- 2. PRIOR TO CONSTRUCTION, CONTRACTOR TO INFORM ESB INTERNATIONAL IF TOPOGRAPHICAL SURVEY DATA OF ADJACENT STREAM INDICATES THAT IT MAY AFFECT THE FEASABILITY OF PROPOSED DESIGN
- B. A RISK ASSESSMENT, CARRIED OUT BY AN APPROPRIATELY QUALIFIED ENGINEER, IS TO BE CARRIED OUT ON EACH EXCAVATION PRIOR TO ANY CIVIL WORKS COMMENCING.
- MATERIAL SPECIFICATION IN ACCORDANCE WITH TII SPECIFICATION FOR ROAD WORKS.


# **ACRONYMS**

G.L = GROUND LEVEL

T.O.S = TOP OF SLAB

= INVERT LEVEL

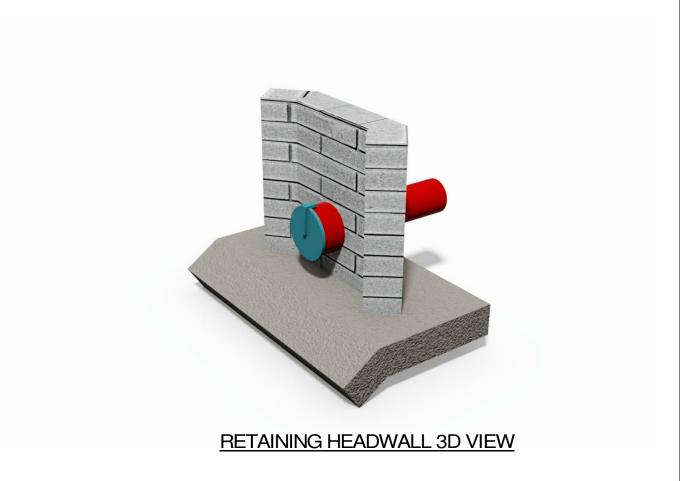

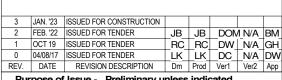

Purpose of Issue - Preliminary unless indicated

Client Approval □ Planning □ Tender □ Construction □ As-Built □



generations

Engineering and Major Projects, One Dublin Airport Central, Dublin Airport, Cloghran, Co. Dublin, K67 XF72, Ireland.

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Client ESB NETWORKS

Project

COOLNABACKY 400 kV STATION

ontract

CP0585 LAOIS KILKENNY REINFORCEMENT PROJECT Drawing Tit

COOLNABACKY 400 kV STATION CIVIL HEADWALL DETAIL

Production Unit

Civil & Environmental Engineering

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DRAWN PRODUCED VERIFIED 1 VERIFIED 2 APPROVED APPD DATE

DRAWN PRODUCED VERIFIED 1 VERIFIED 2 APPROVED APPD DATE
J.Byrne J.Byrne R.McGowan N/A B.Murphy JAN. 2023

Client Ref No. of Sheets Size A3 As

Drawing Number | Sheet | Indicated | Hev | PE493-D108-054-011-003